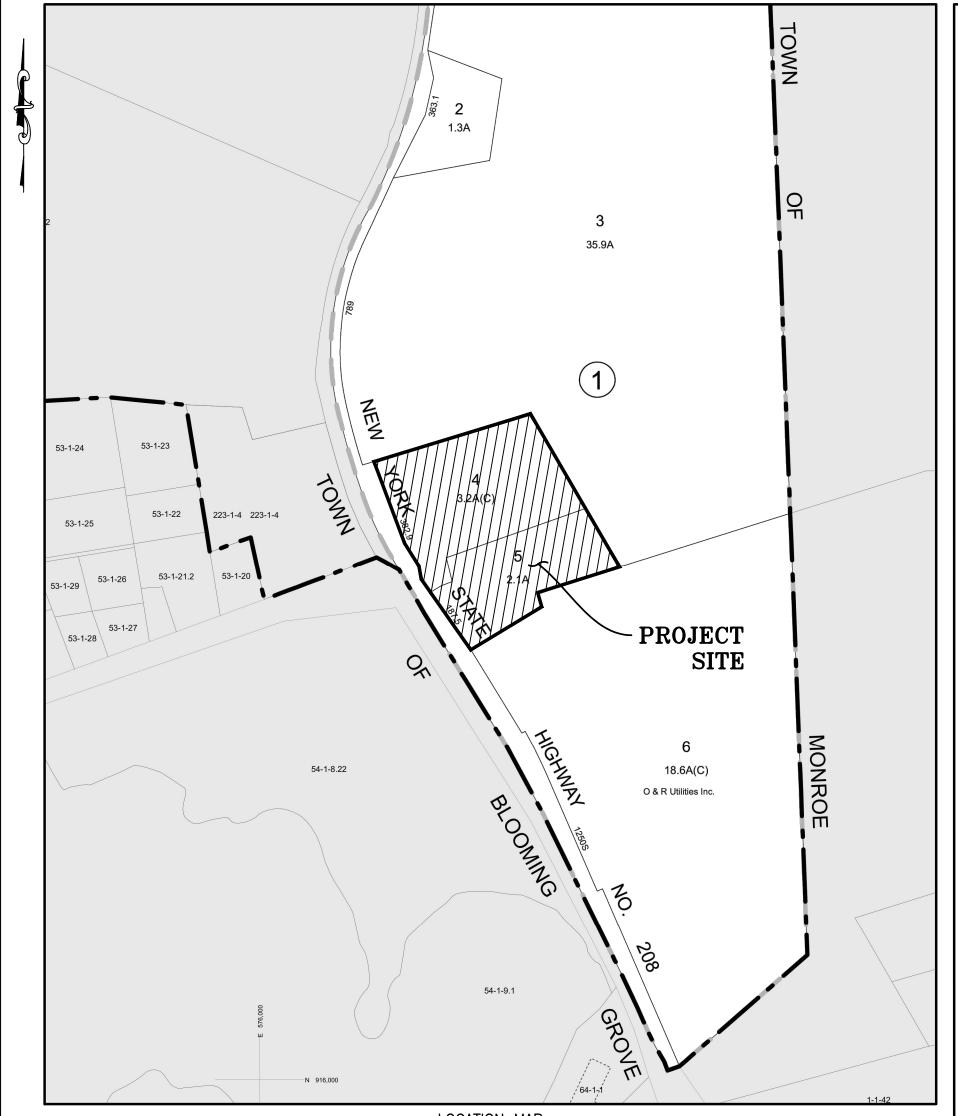
# SITE PLAN FOR 520 - 530 ROUTE 208 VILLAGE OF SOUTH BLOOMING GROVE, ORANGE COUNTY, NY.



**LOCATION MAP** SCALE: 1"=400' SOURCE: ORANGE COUNTY GIS

DRAWING LIST

before you dig

### TAX MAP NUMBER

SECTION: 224 BLOCK: 1 LOT: 4, 5

**DEED REFERENCE** 

S.B.L: 224-1-5 LIBER: 13217 LIBER: 15428 PAGE: 827 PAGE: 555

## TOTAL TRACT AREA

AND CHANGES.

S.B.L: 224-1-4 S.B.L: 224-1-5 91,062.73± S.F. 140,845.45± S.F. =2.09± ACRES  $=3.23\pm$  ACRES

#### **OWNER & APPLICANT**

S.B.L: 224-1-4 S.B.L: 224-1-5 520 ROUTE 208 LLC YOEL WAGSCHAL 9 KINGSVILLE DR 9 DALLAS DRIVE MONROE NY 10950 MONROE, NY 10950

WARNING- IT IS A VIOLATION OF NEW YORK EDUCATIONAL LAW, SECTION 7209.2, FOR ANY PERSON, UNLESS ACTING UNDER THE DIRECTION OF A LICENSED PROFESSIONAL Dig Safely. New York ENGINEER OR LAND SURVEYOR, TO ALTER THIS DOCUMENT ANY WAY. IF ALTERED, THE ALTERING PERSON SHALL

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SHEET #	SHEET TITLE	ORIGINAL DATE / LAST REVISED DATE
01 OF 10	TITLE SHEET	12-14-23 / 05-06-24
02 OF 10	EXISTING CONDITIONS MAP	12-14-23 / 05-06-24
03 OF 10	DEMOLITION PLAN	12-14-23 / 05-06-24
04 OF 10	SITE PLAN	12-14-23 / 05-06-24
05 OF 10	GRADING & UTILITY PLAN	12-14-23 / 05-06-24
06 OF 10	EROSION & SEDIMENT CONTROL PLAN	12-14-23 / 05-06-24
07 OF 10	EROSION & SEDIMENT CONTROL DETAILS	12-14-23 / 05-06-24
08 OF 10	DRIVEWAY PROFILE	12-14-23 / 05-06-24
09 OF 10	TRUCK (SU-40) TURNING DIAGRAMS 01	12-14-23 / 05-06-24
10 OF 10	TRUCK (SU-40) TURNING DIAGRAMS 01	12-14-23 / 05-06-24

SCALE

0 20 40

# **OWNER'S CONSENT NOTE:** ORANGE, IF SO REQUIRED.

SIGNATURE OF OWNER(S) DATE

TITLE SHEET SCALE: 1"=40' DATE DESCRIPTION REVISION BY ADDITION OF PROPOSED SITE UTILITIES 5-6-24 PER CDRC & PB MTGS 1-9-24 THIS SHEET IS NOT VALID WITHOUT ALL OF THE SHEETS THAT COMPRISE THE SET MICHAEL A. MORGANTE, P.E. LIC. NO. 78577 COPYRIGHT 2023, ARDEN CONSULTING ENGINEERS, P.L.L.C. - ALL RIGHTS RESERVED

N/F ORANGE AND ROCKLAND UTILITIES INC.

### ARDEN CONSULTING ENGINEERS, PLLC P.O. BOX 340 MONROE, N.Y. TEL: (845) 782-8114 FAX: (845) 782-2946 WWW.ARDENCONSULTING.NET

SITE PLAN FOR 520 - 530 ROUTE 208 VILLAGE OF SOUTH BLOOMING GROVE ORANGE COUNTY, N.Y.

TITLE SHEET

23-010 SCALE:

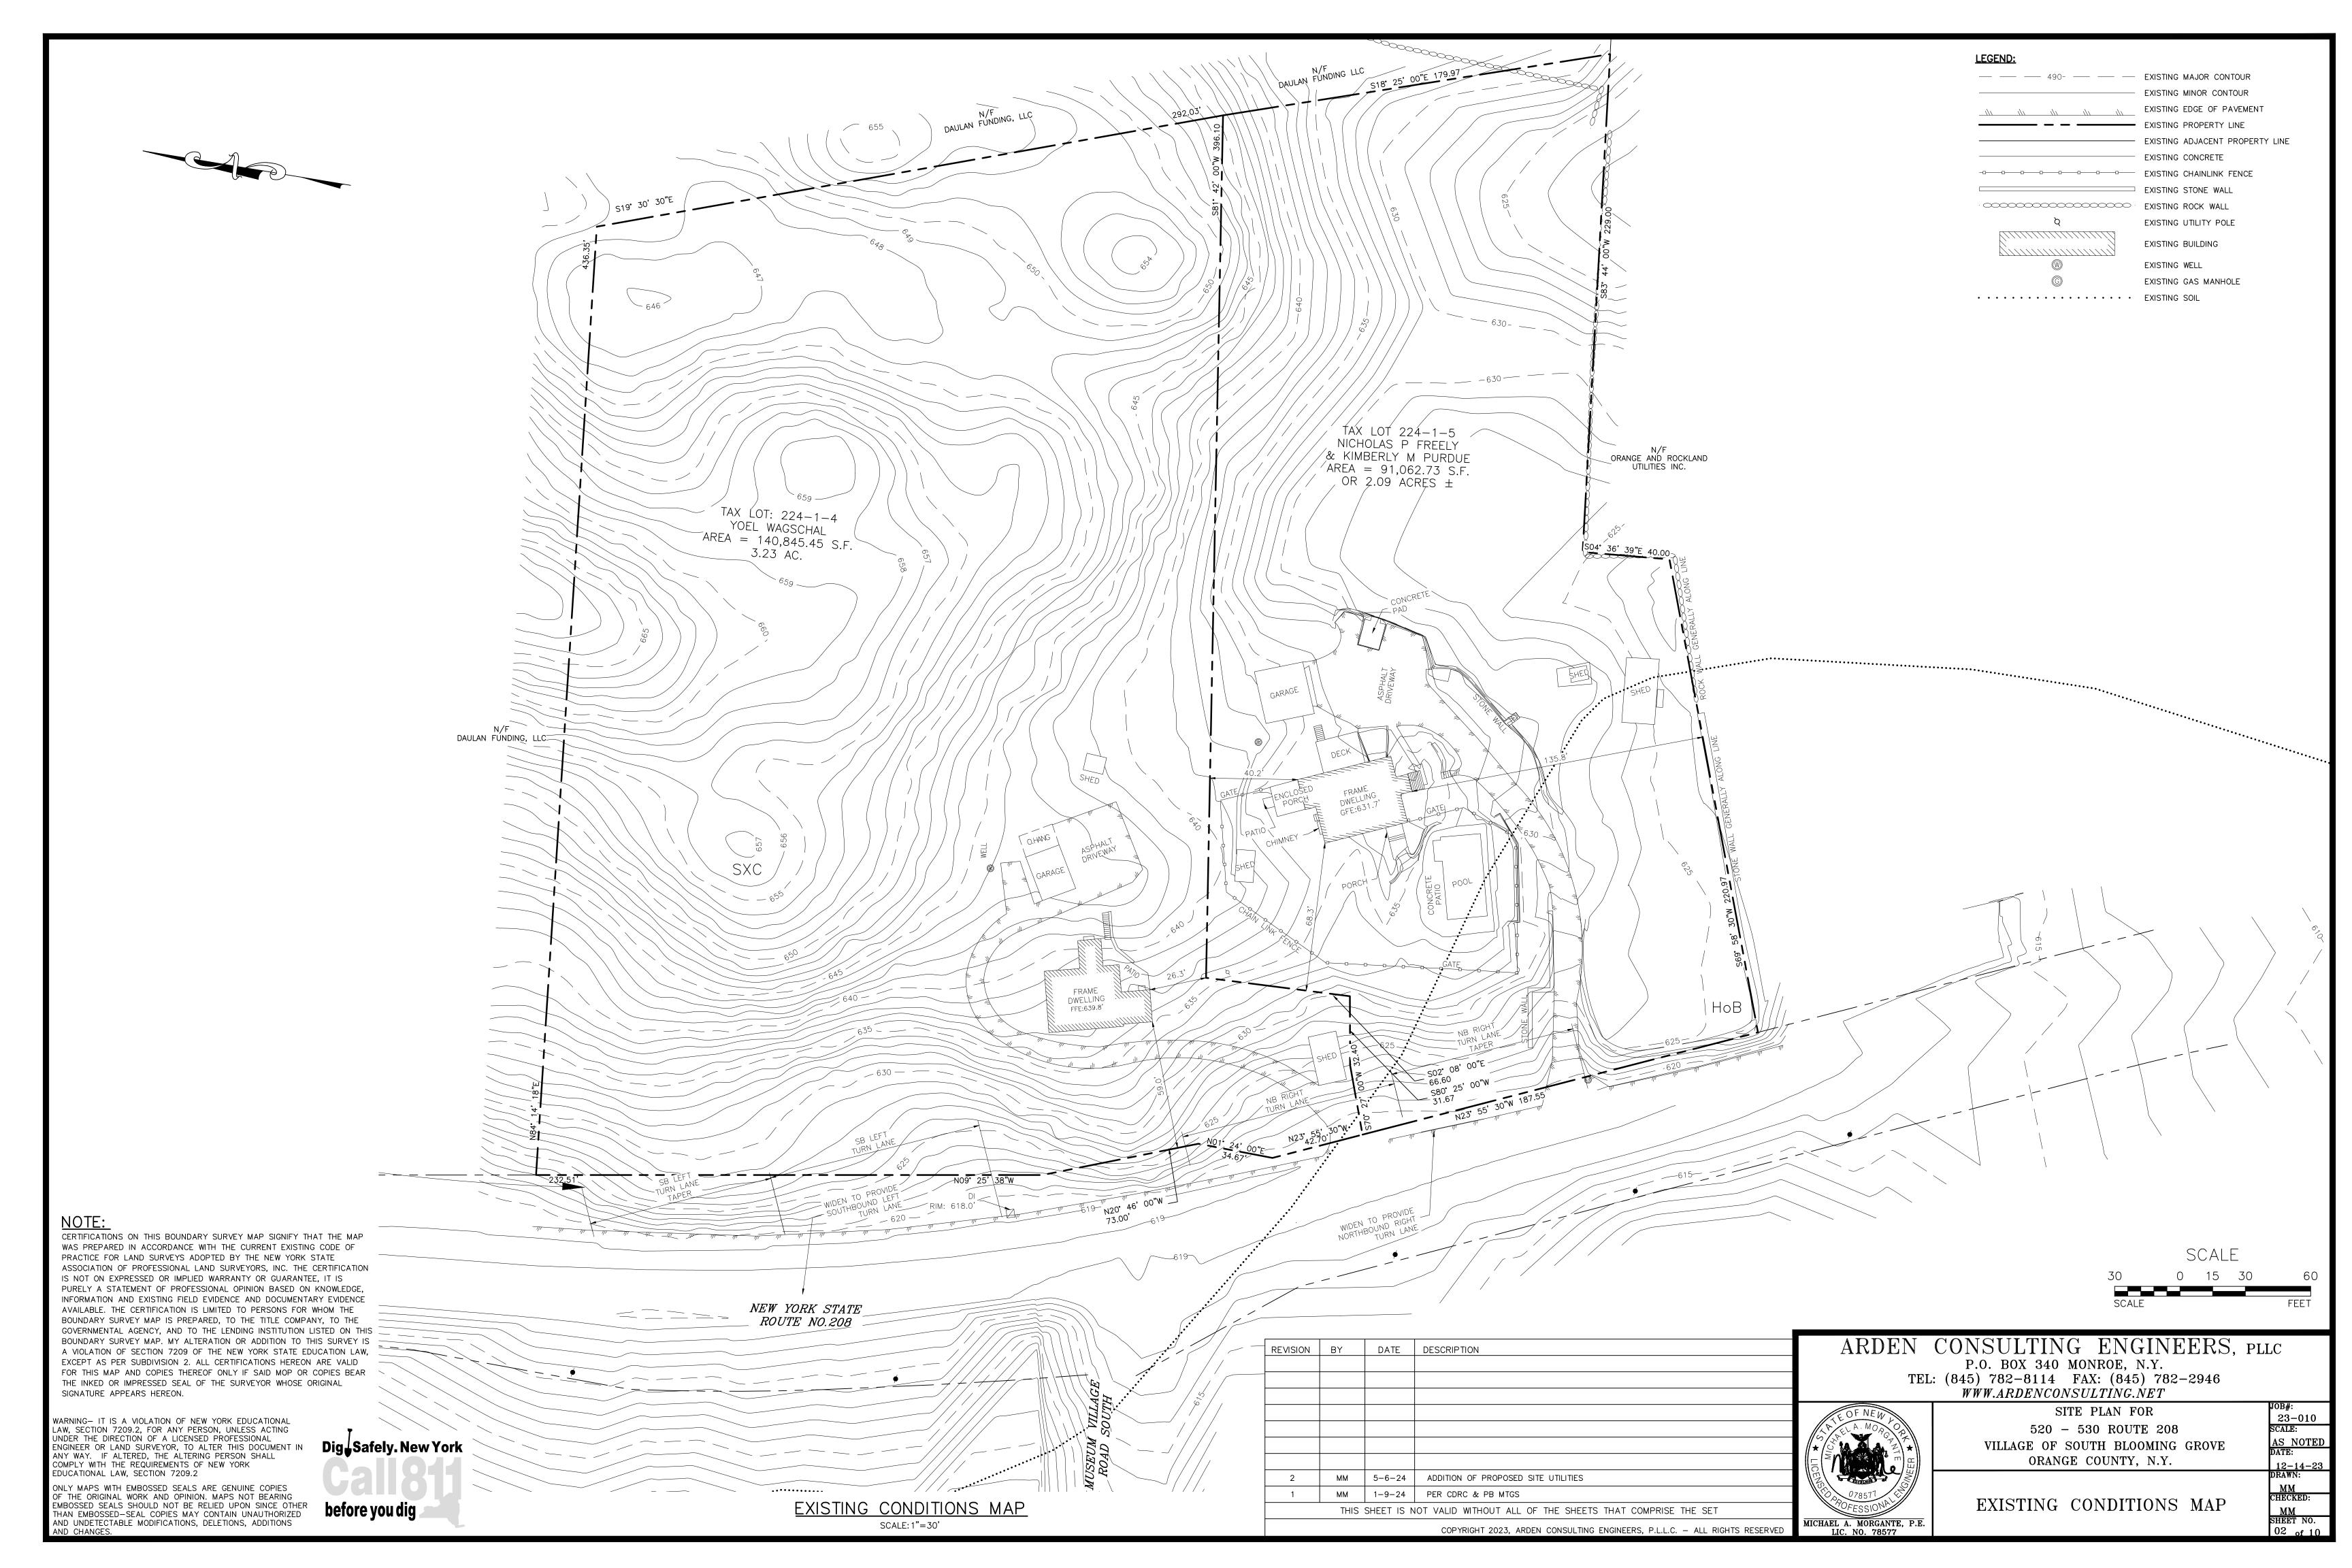
AS NOTED DATE:

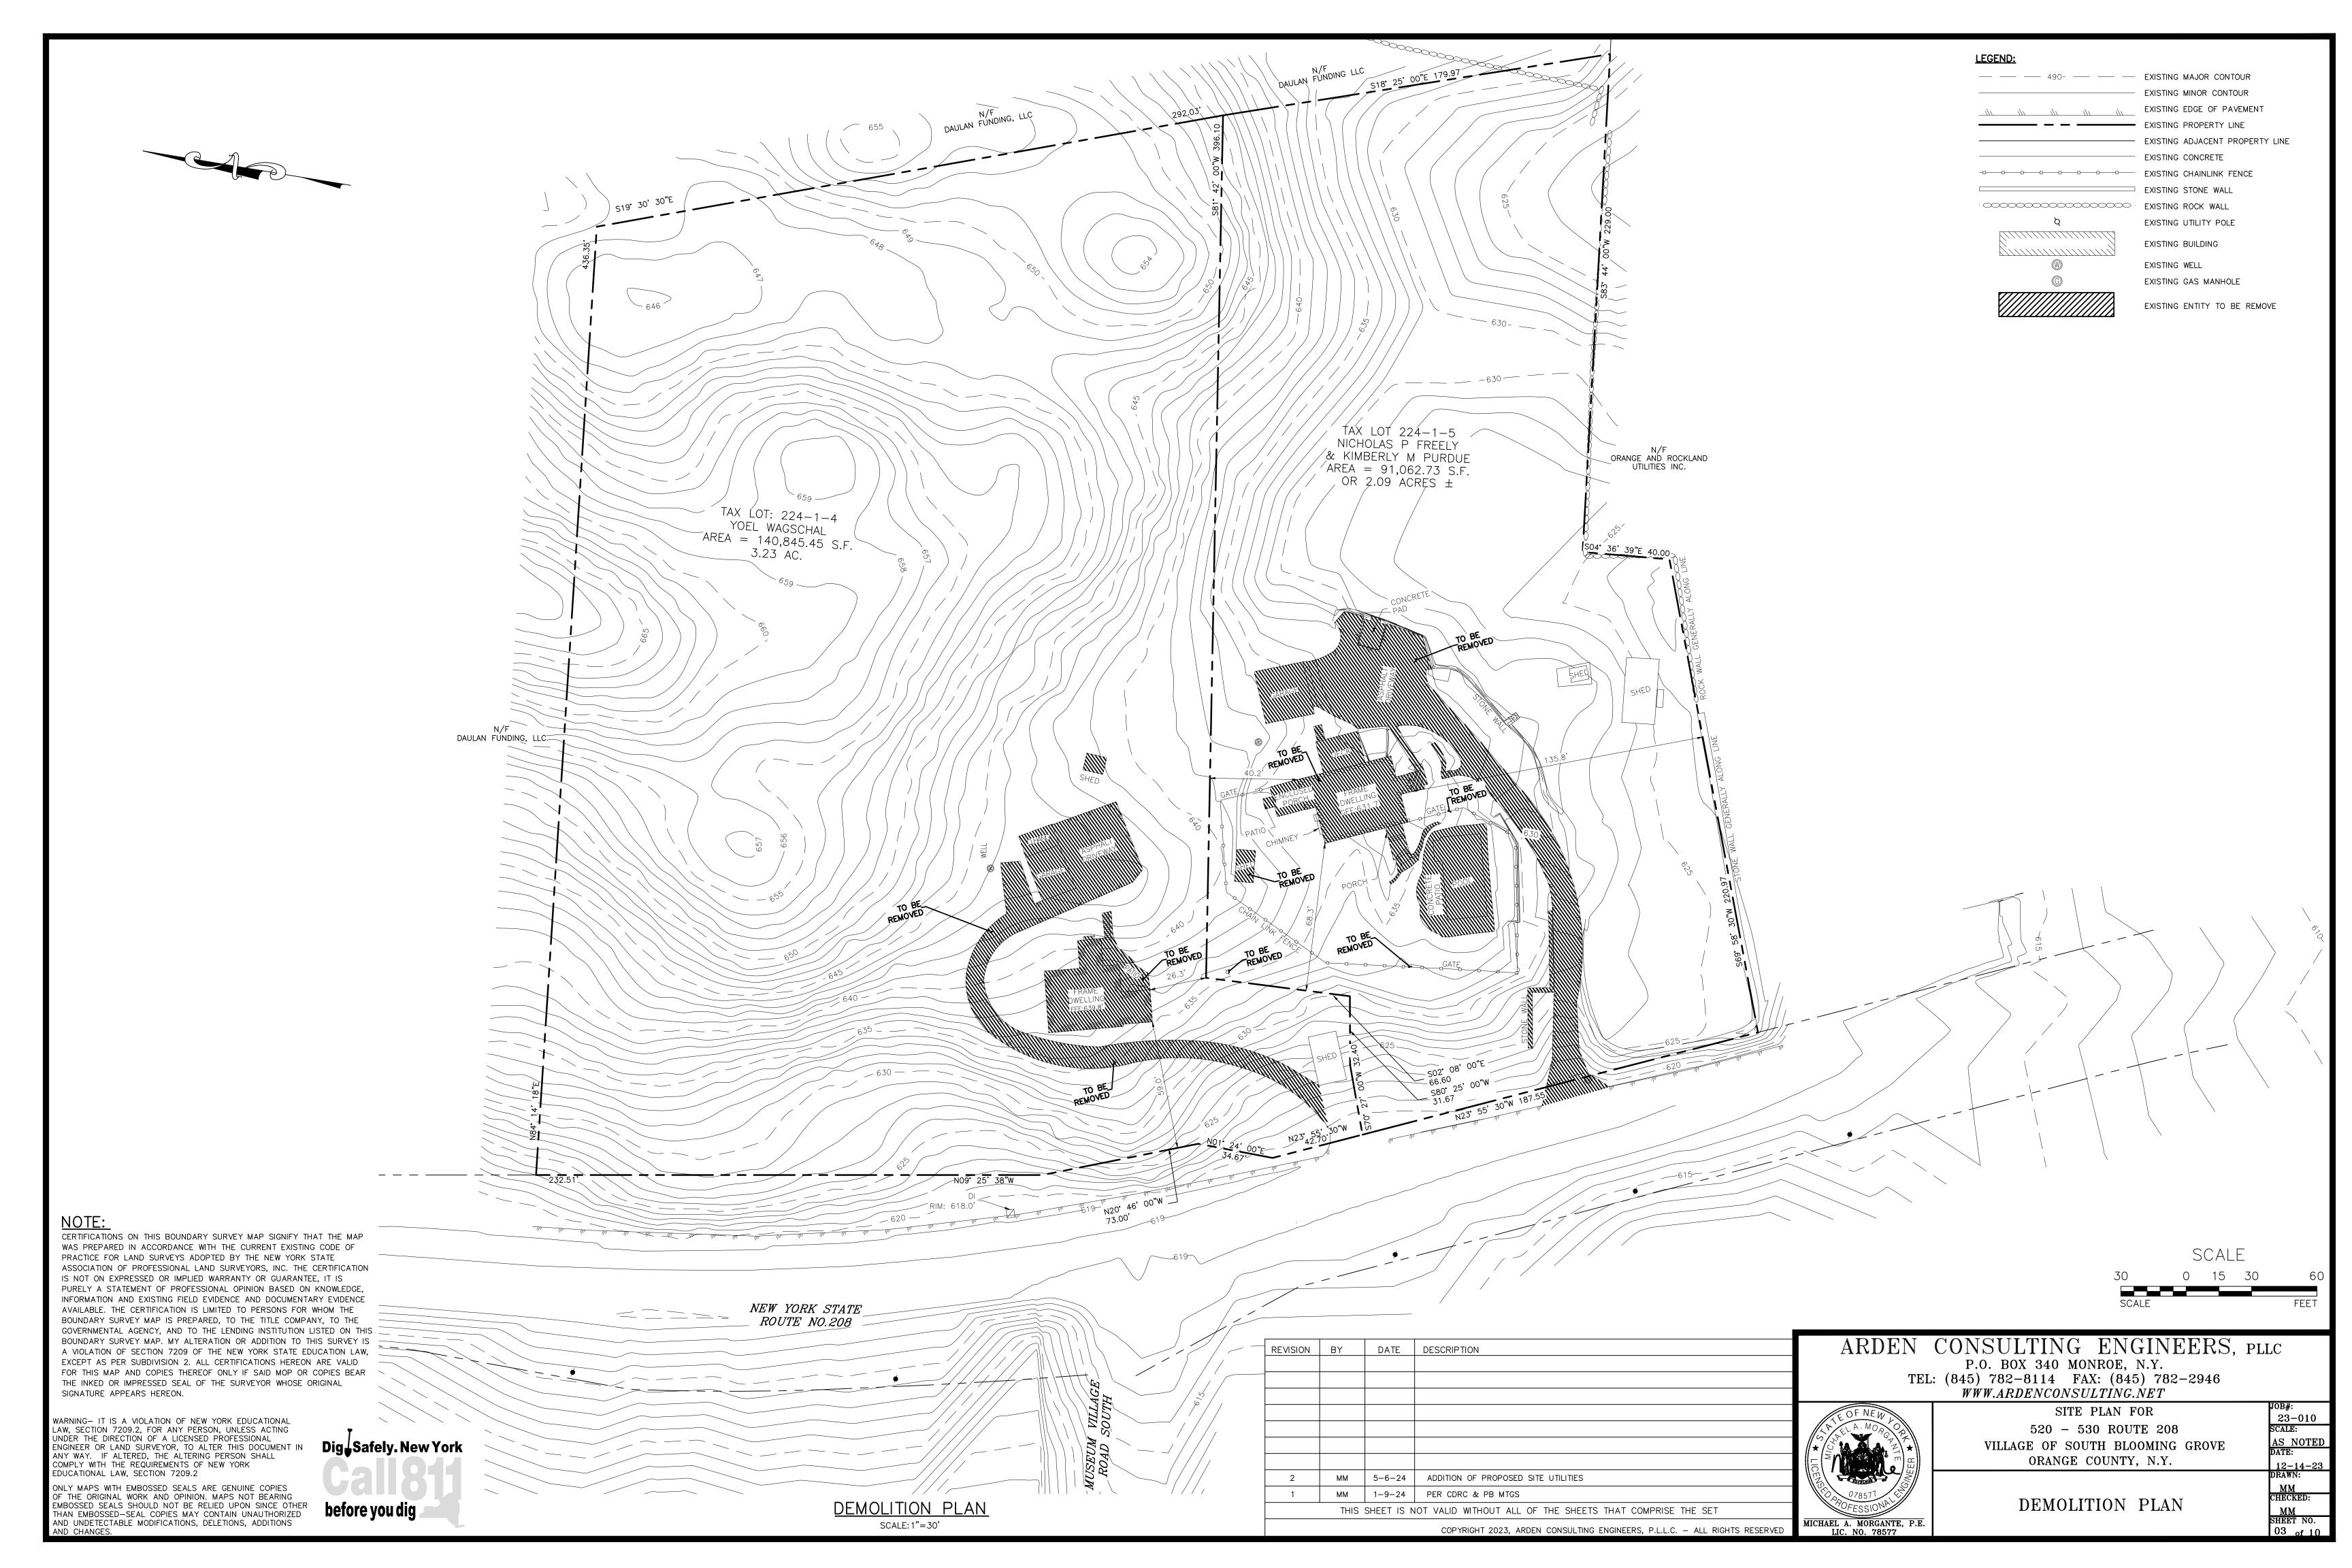
MM CHECKED:

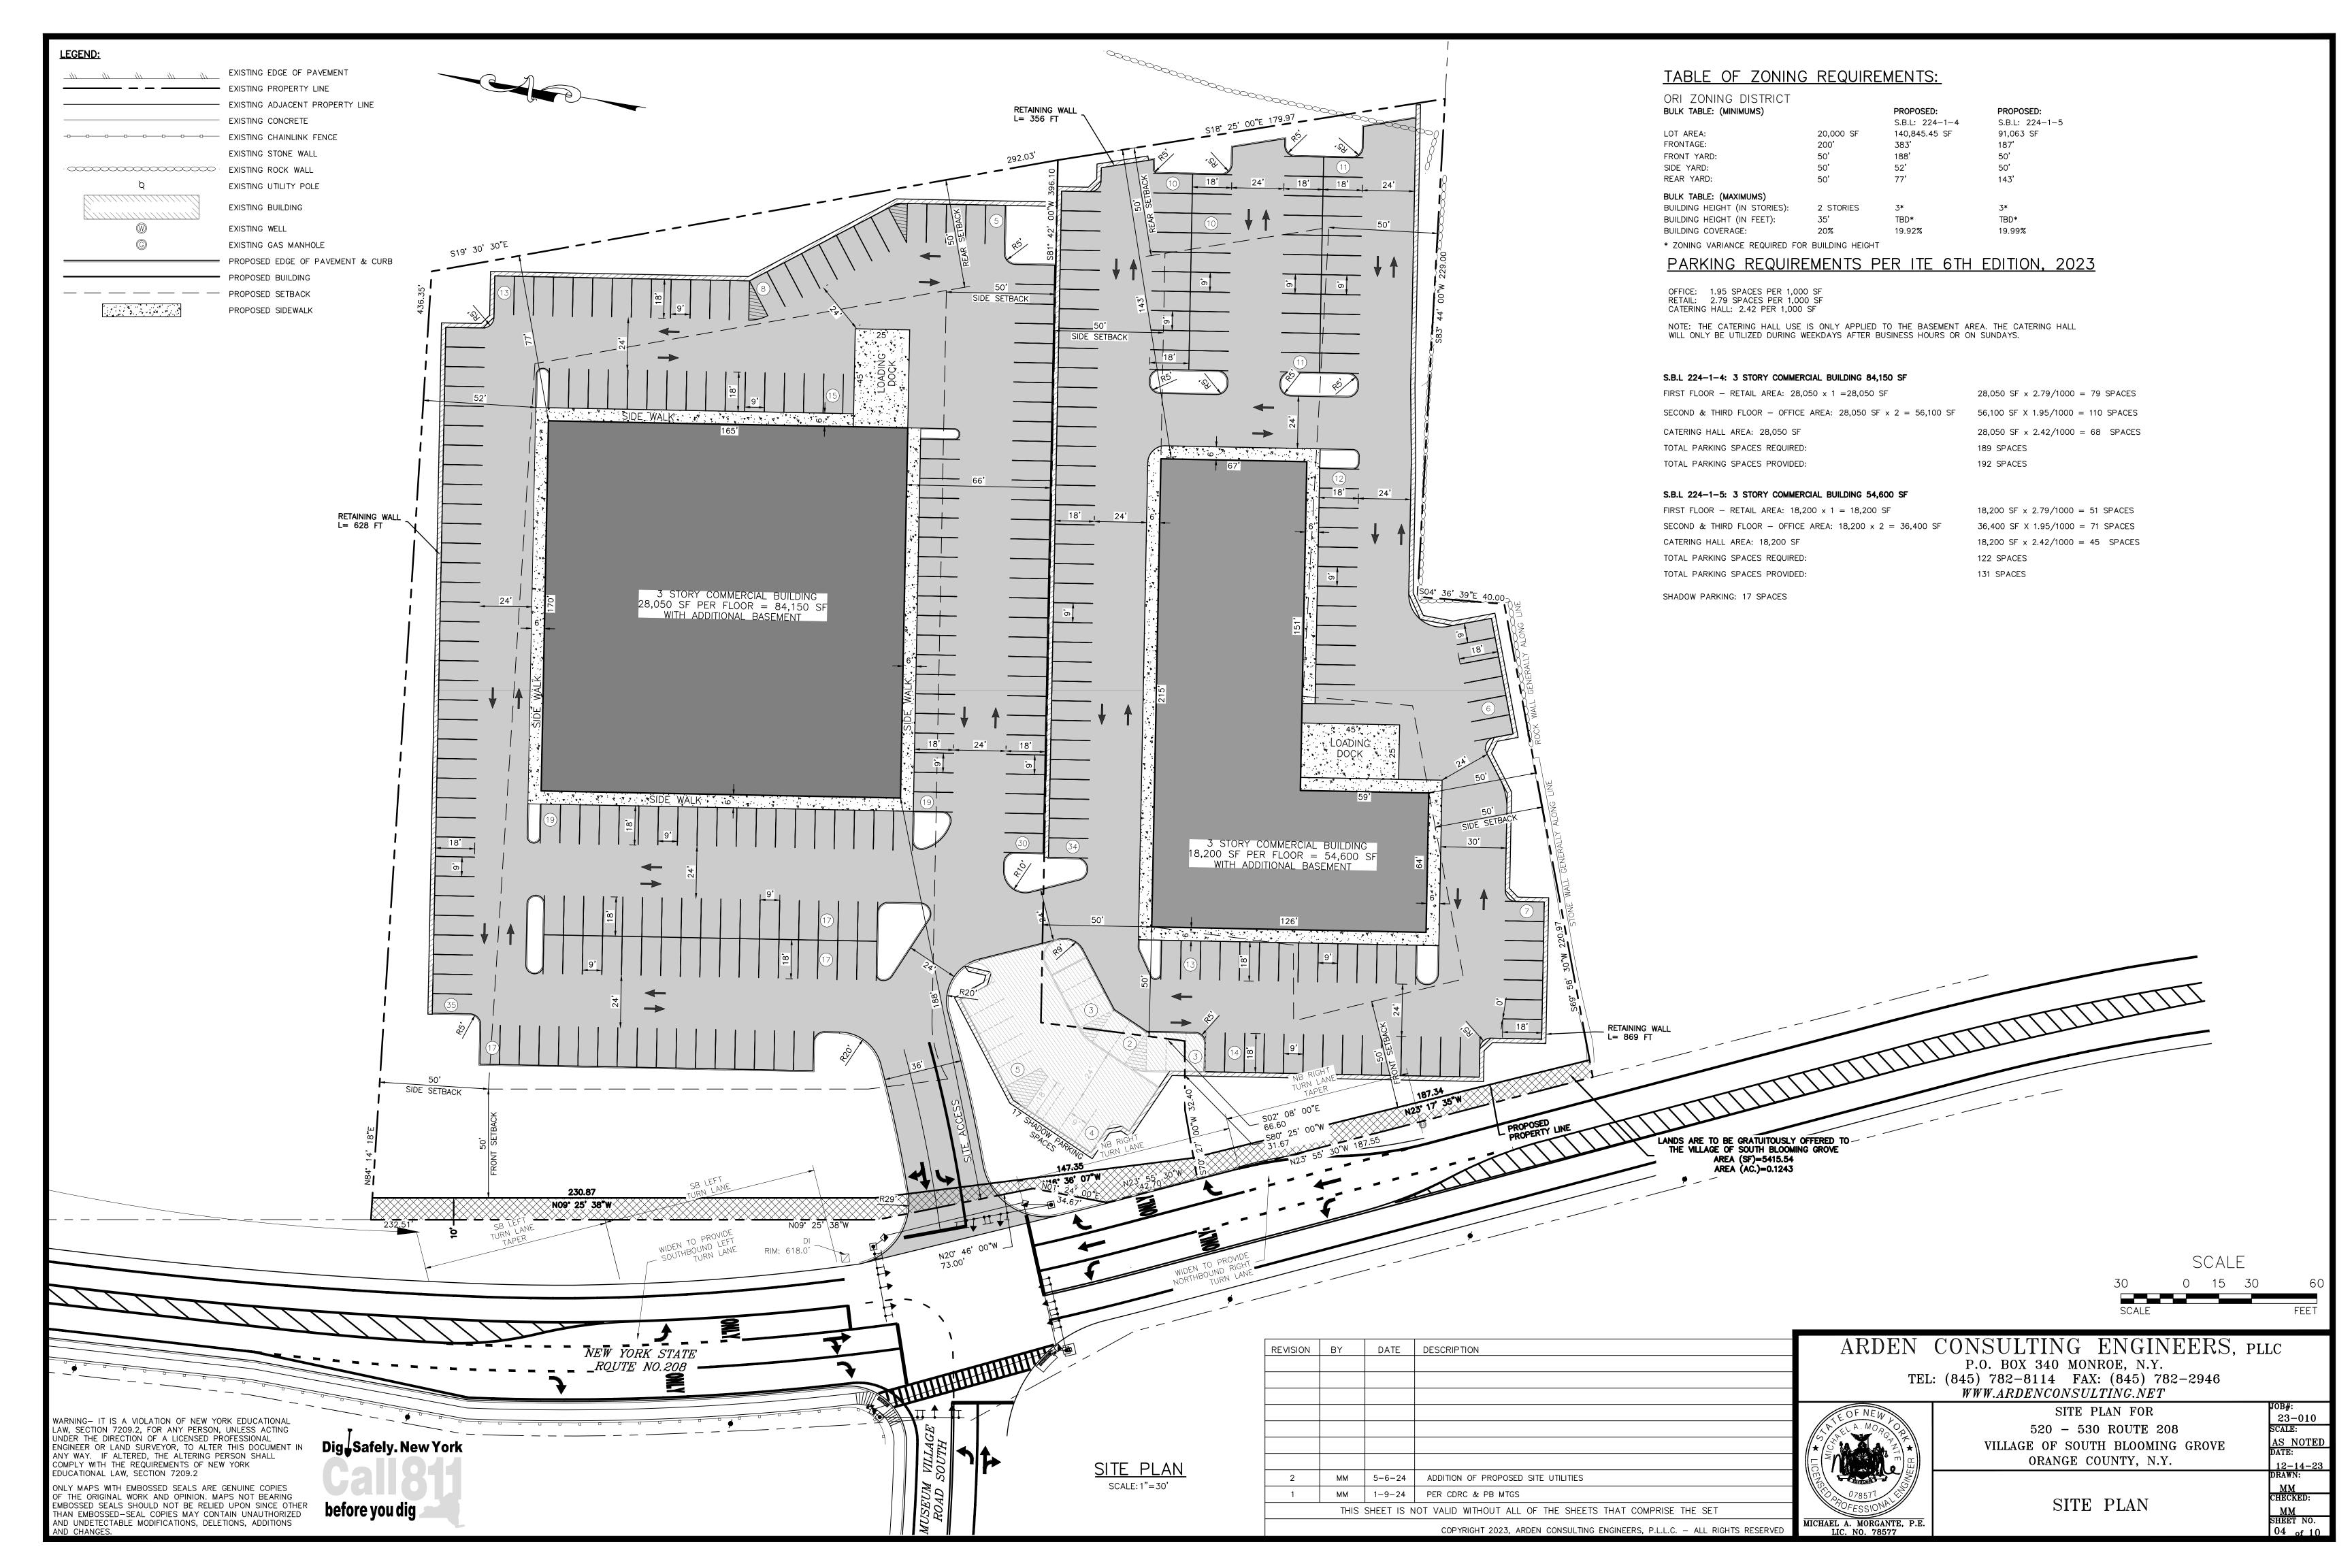
TAX LOT: 224-1-4 YOEL WAGSCHAL AREA = 140,845.45 S.F. 3.23 AC. 3 STORY COMMERCIAL BUILDING 28,050 SF PER FLOOR = 84,150 SF WITH ADDITIONAL BASEMENT N/F DAULAN FUNDING, LLC 3 STORY COMMERCIAL BUILDING 18,200 SF PER FLOOR = 54,600 SF WITH ADDITIONAL BASEMENT NEW YORK STATE
ROUTE NO.208

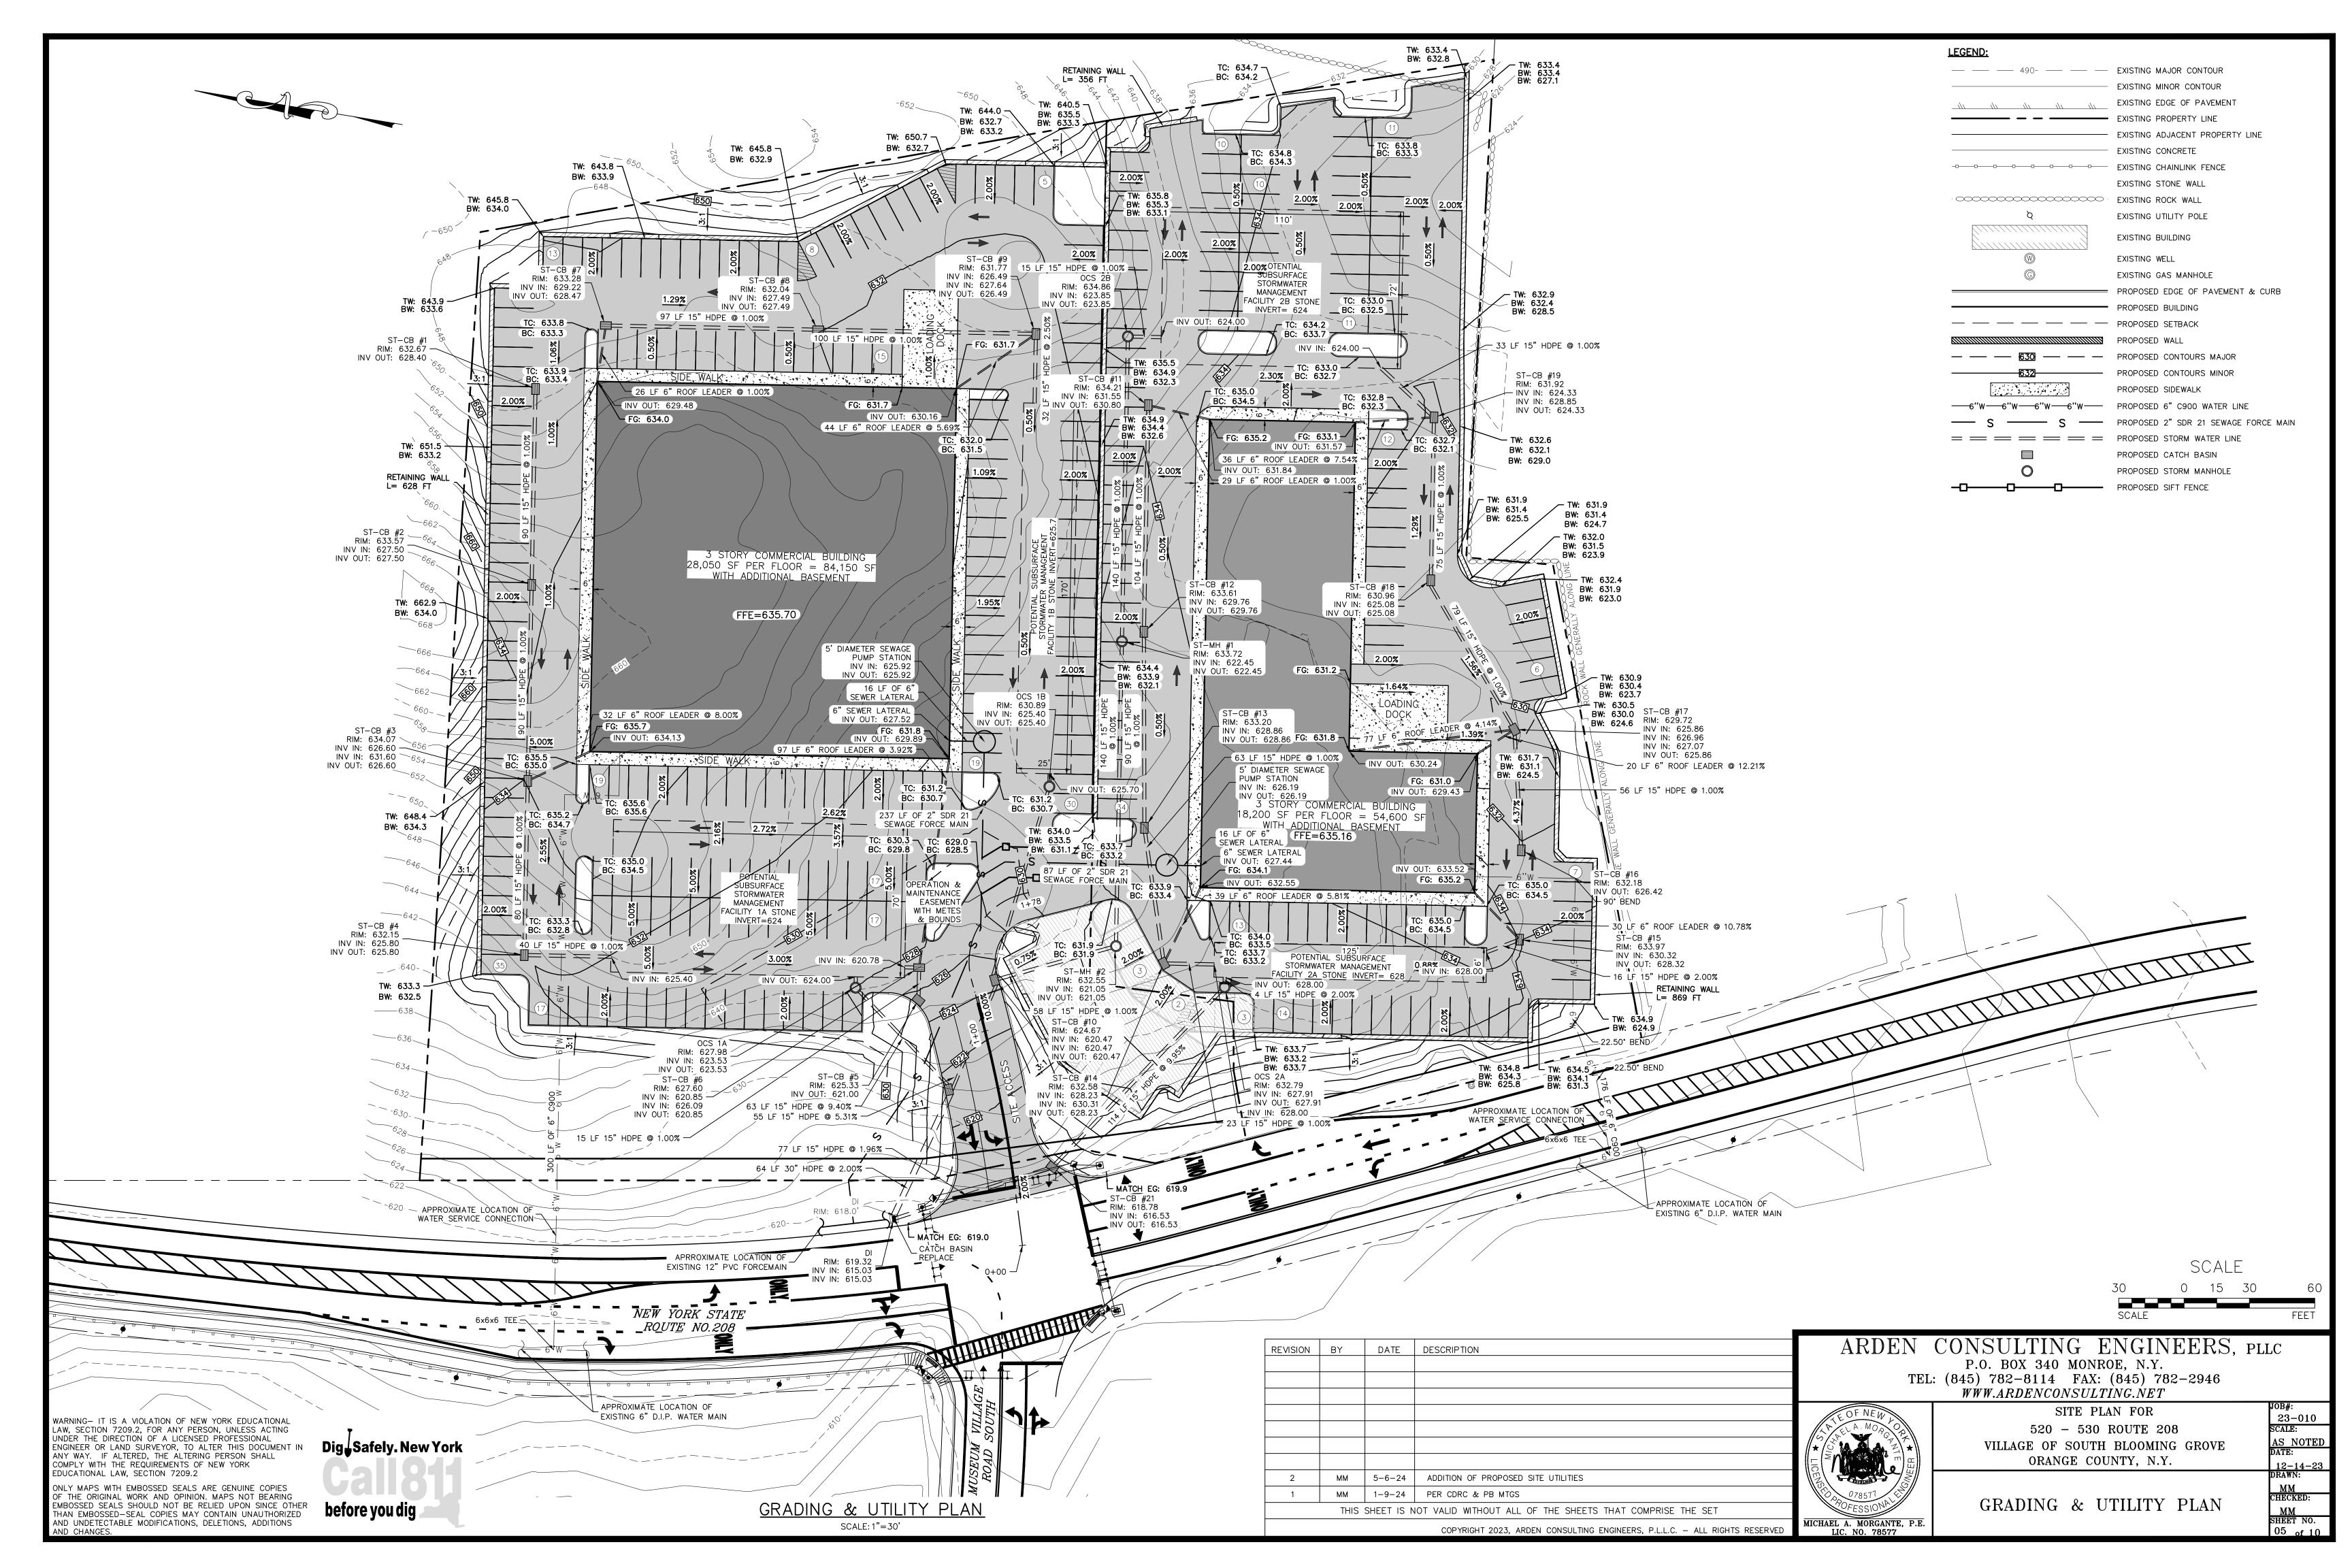
> THE UNDERSIGNED OWNERS OF THE PROPERTY HEREON STATE THAT THEY ARE FAMILIAR WITH THIS PLAN, ITS CONTENTS AND ITS LEGENDS AND HEREBY CONSENT TO ALL SAID TERMS AND CONDITIONS AS STATED HEREON AND TO THE FILING OF THIS PLAN IN THE OFFICE OF THE CLERK OF THE COUNTY OF

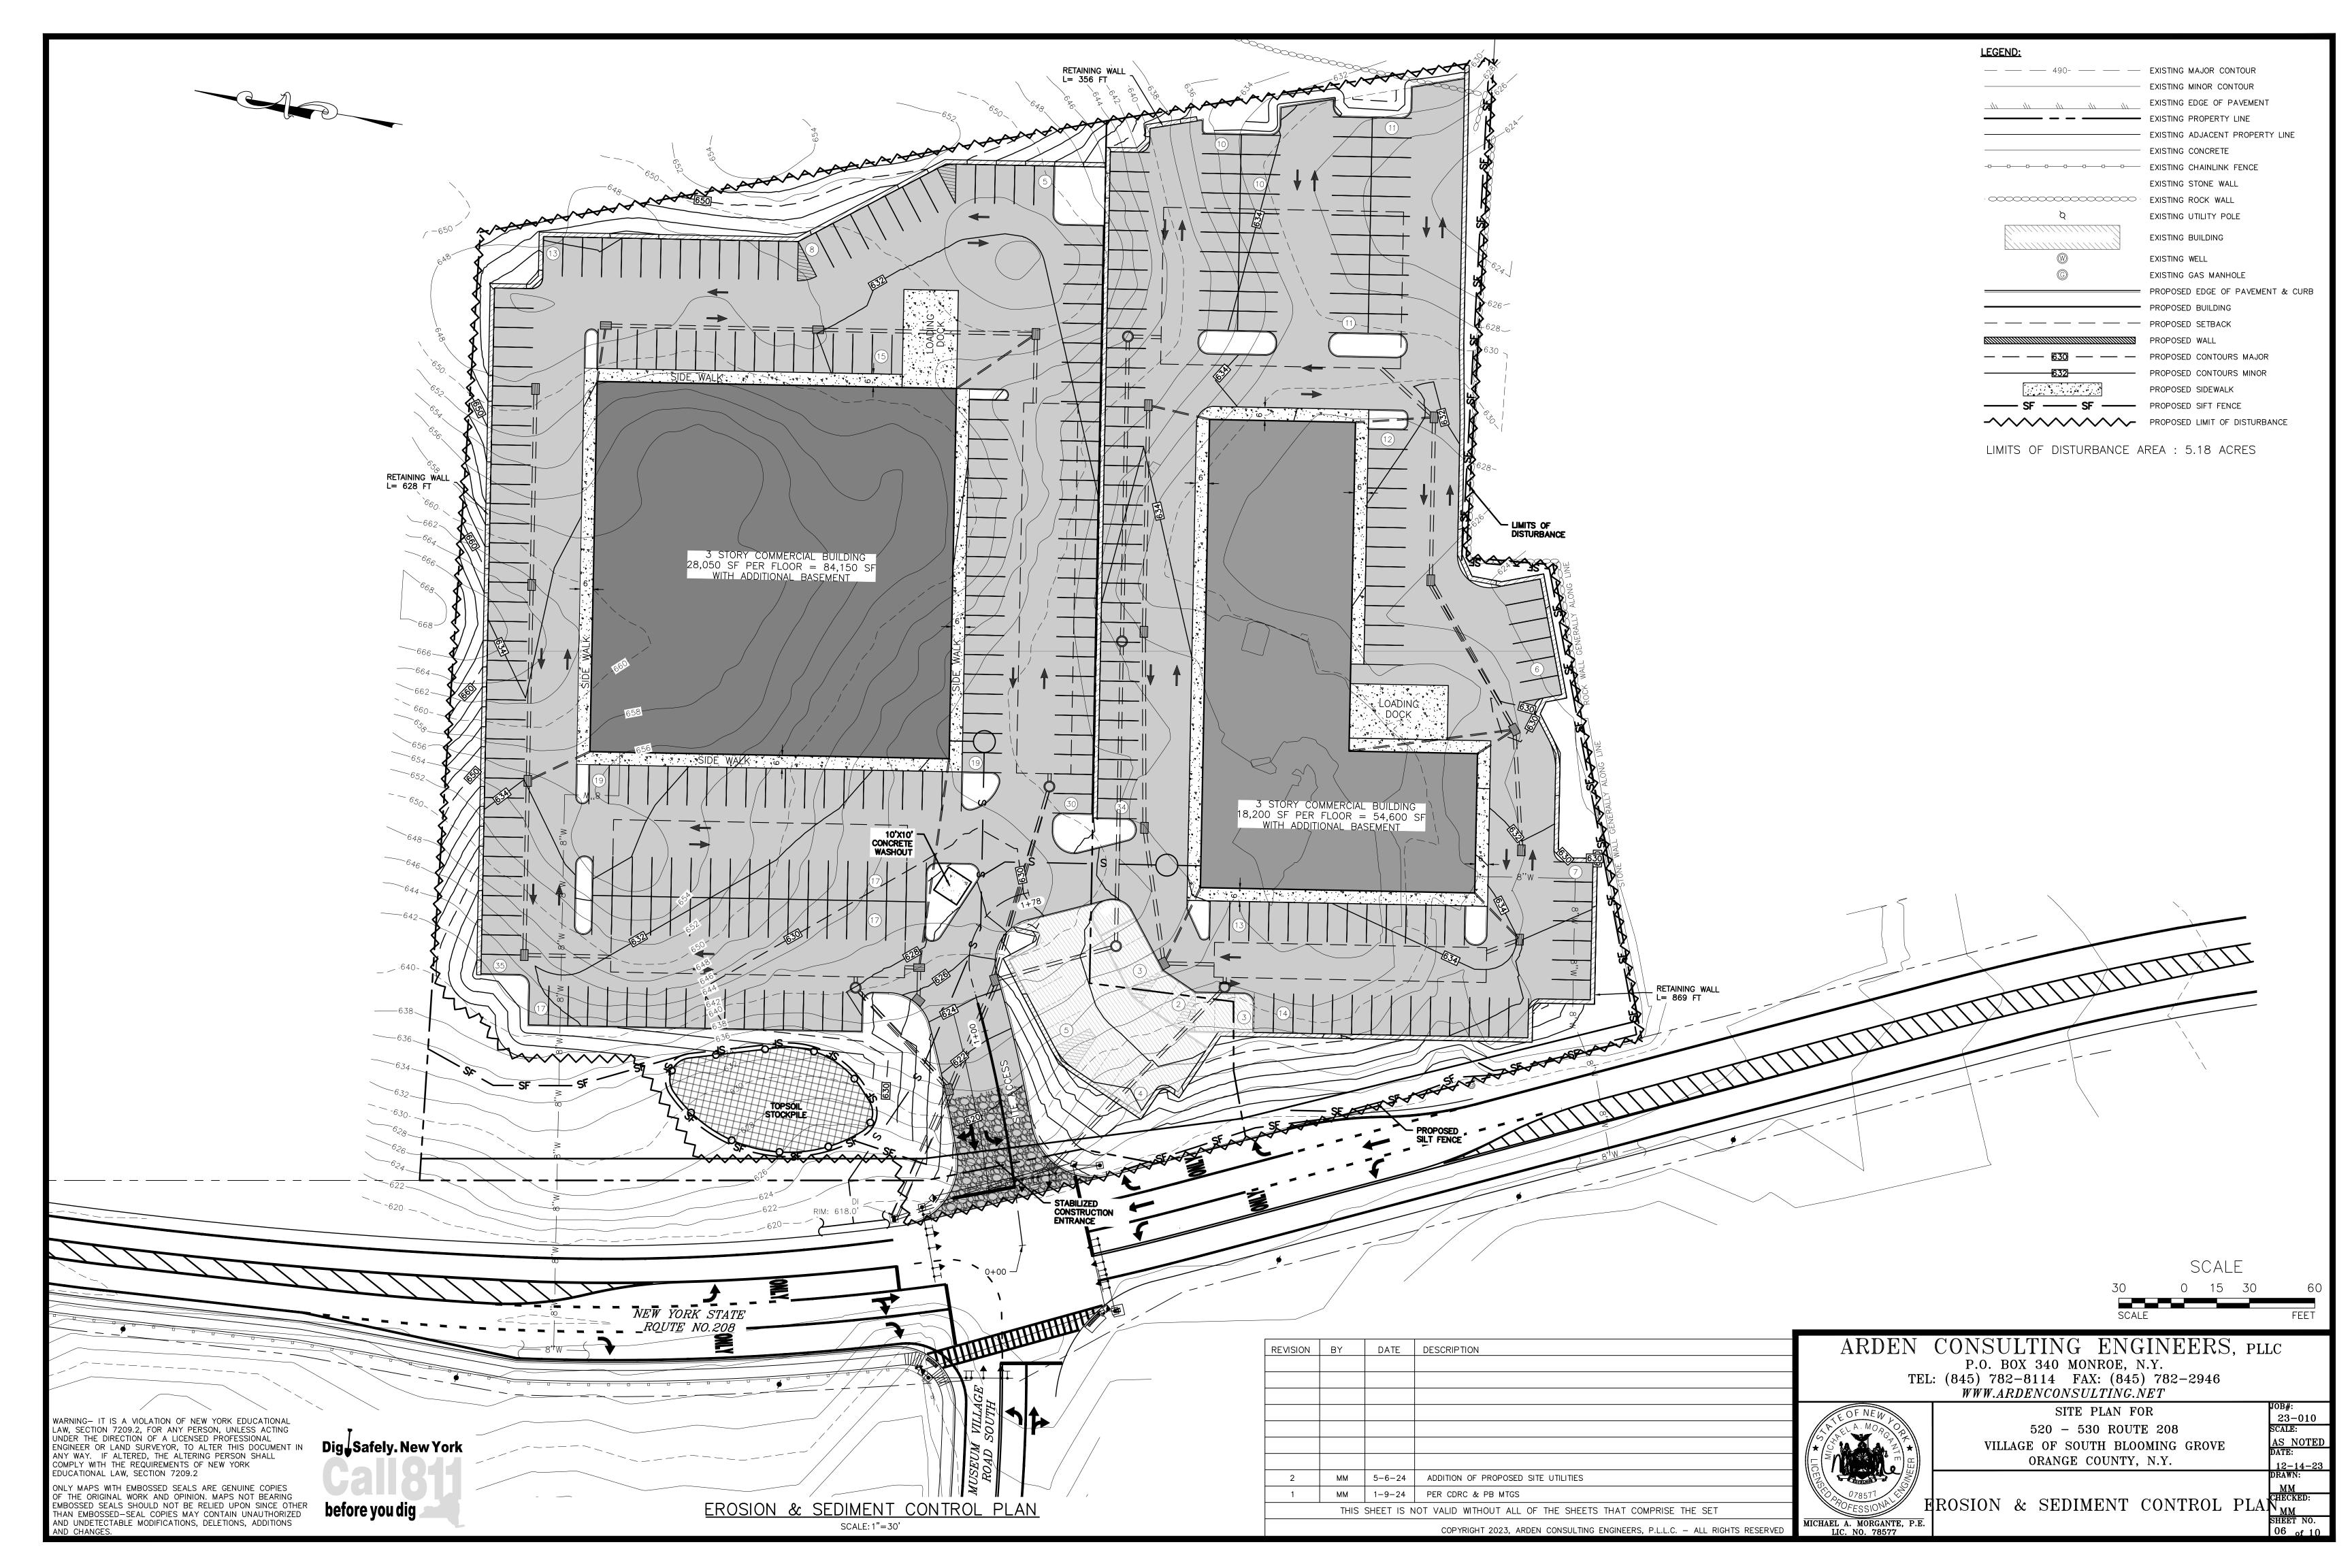
SIGNATURE OF OWNER(S)	DATE
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BEST MANAGEMENT PRACTICES FOR SITE FACILITY MAINTENANCE

THE OWNER WILL BE RESPONSIBLE FOR THE MAINTENANCE AND OPERATION OF ALL SITE RELATED FACILITIES, INCLUDING THE STORM WATER SEDIMENT AND DETENTION BASINS AND THE FOLLOWING MEASURES AND/OR STRUCTURES, AS APPLICABLE AND SHOWN ON THE PLANS:

#### WATER QUALITY INLETS

1. WATER QUALITY INLETS SHALL BE CLEANED OUT AT LEAST TWICE A YEAR TO REMOVE POLLUTANTS. REMOVED MATERIAL SHOULD BE TAKEN TO A TREATMENT PLANT OR APPROVED LANDFILL FOR DISPOSAL 2. STORM WATER INLETS THROUGHOUT THE SITE SHALL BE INSPECTED ANNUALLY FOR ACCUMULATED SEDIMENT OR OTHER PROBLEMS AND REPAIRED AS NECESSARY.

1. PARKING AREA AND ROADWAY PAVEMENTS SHALL BE SWEPT ON A REGULAR BASIS TO REMOVE ACCUMULATED SEDIMENT. COLLECTED SEDIMENT SHALL BE REMOVED TO AN APPROVED DISPOSAL SITE WHICH WILL NOT ALLOW THE RE-ENTRANCE OF SILT INTO THE STORM WATER DRAINAGE SYSTEM.

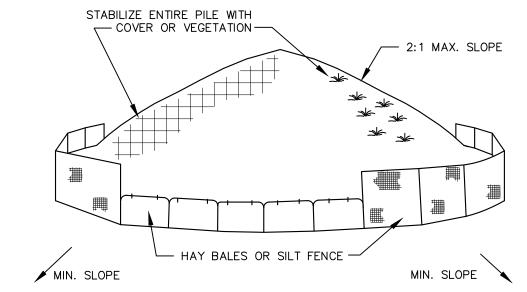
#### VEGETATIVE STABILIZATION

1. ALL VEGETATIVE PLANTING ON AREAS WHICH HAVE BEEN DISTURBED AND ARE FINISH GRADED SHALL BE INSPECTED AFTER EACH RAIN EVENT. PLANTING (OR SEEDING) SHALL BE MAINTAINED IN A VIABLE CONDITION TO STABILIZE THE SOIL AND TO PREVENT SOIL EROSION. RESTORE ALL SITE PLANTING AND/OR SEEDING WHICH HAS BEEN DAMAGED TO A VIABLE CONDITION 2. IF VEGETATIVE STABILIZATION HAS BEEN DAMAGED FROM STORM WATER EROSION, CORRECT UPSTREAM CONDITIONS WHICH CAUSED THE EROSION. CHECK DAMS MAY BE REQUIRED IN DRAINAGE WAYS, AND STONE OUTFALL APRONS MAY BE REQUIRED TO BE REPAIRED AT STORM WATER OUTLETS.

1. CONSTRUCTION ACTIVITIES WILL OCCUR DURING WEEKDAYS COMMENCING AT 7:00 AM AND TERMINATING AT 6:00 PM

#### **EROSION AND SILTATION CONTROL NOTES:**

1. GRADED AREAS — UPPER ELEVATIONS: PROVIDE TEMPORARY DRAINAGE SWALES, 1% GRADE MIN., TO DIRECT RUNOFF AWAY FROM CONSTRUCTION SITES. DISCHARGE AREAS AND ENERGY DISPERSION REQUIREMENTS TO BE ACCEPTABLE TO OWNER. 2. GRADED AREAS - LOWER ELEVATIONS: PROVIDE DRAINAGE SWALES, 1% MIN. GRADES, WITH STAKED AND SECURED HAY BALE BERMS TO PREVENT DOWN STREAM AND DOWN GRADIENT SILTATION.



#### INSTALLATION NOTES:

- 1. AREA CHOSEN FOR STOCKPILING OPERATIONS SHALL BE DRY AND STABLE
- 2. MAXIMUM SLOPE OF STOCKPILES SHALL BE 2:1.
- 3. UPON COMPLETION OF SOIL STOCKPILING EACH PILE SHALL BE SURROUNDED WITH EITHER SILT FENCING OR HAY BALES, THEN STABILIZED WITH VEGETATION OR COVERED.
- 4. SEE SPECIFICATIONS FOR INSTALLATION OF SILT FENCE.

<u>SOIL STOCKPILE DETAIL</u>

#### SPECIFICATIONS FOR VEGETATIVE ESTABLISHMENT:

A. SEEDBED PREPARATION: AREA TO BE SEEDED SHALL BE LOOSE AND FRIABLE TO A DEPTH OF AT LEAST 3 INCHES. THE TOP LAYER SHALL BE LOOSENED BY RAKING, DISKING OR OTHER ACCEPTABLE MEANS BEFORE SEEDING OCCURS. FOR SITES LESS THAN 5 ACRES, APPLY 100 POUNDS OF DOLOMITIC LIMESTONE AND 21 POUNDS OF 10-20-20 FERTILIZER PER 1,000 SF. HARROW OR DISK LIME AND FERTILIZER INTO THE SOIL TO A DEPTH OF AT LEAST 3 INCHES ON SLOPES FLATTER THAN 3:1. B. SEEDING: APPLY 5-6 POUNDS PER 1,000 SF OF RYE SEED MIX BETWEEN FEBRUARY 1 AND MAY 15 OR BETWEEN AUGUST 15 AND OCTOBER 31. APPLY SEED UNIFORMLY ON A MOIST FIRM SEEDBED WITH A CYCLONE SEEDED DRILL, CULTIPACKER SEEDER OR HYDROSEEDER (SLURRY INCLUDES SEEDS AND FERTILIZER, RECOMMENDED ON STEEP SLOPES ONLY). MAXIMUM SEED DEPTH SHOULD BE 1/4 INCH IN CLAYEY SOILS AND 1/2 INCH IN SANDY SOILS WHEN USING OTHER THAN THE HYDROSEEDER METHOD. IRRIGATE IF SOIL MOISTURE IS DEFICIENT TO SUPPORT ADEQUATE GROWTH UNTIL VEGETATION IS FIRMLY ESTABLISHED. SELECT SEED MIXTURES FROM SECTION 3, NYS GUIDELINES FOR URBAN EROSION & SEDIMENT CONTROL. C. MULCHING: MULCH SHALL BE APPLIED TO ALL SEEDED AREAS IMMEDIATELY AFTER SEEDING. DURING THE TIME PERIODS WHEN SEEDING IS NOT PERMITTED, MULCH SHALL BE APPLIED IMMEDIATELY AFTER GRADING. MULCH SHALL BE UNROTTED, UNCHOPPED, SMALL GRAIN STRAW APPLIED AT A RATE OF 2 TONS PER ACRE OR 90 POUNDS PER 1,000 SQUARE FEET (2 BALES). IF A MULCH ANCHORING TOOL IS USED, APPLY 2.5 TONS PER ACRE. MULCH MATERIALS SHALL BE RELATIVELY FREE OF ALL KINDS OF WEEDS AND SHALL BE COMPLETELY FREE OF PROHIBITED NOXIOUS WEEDS. SPREAD MULCH UNIFORMLY, MECHANICALLY,

OR BY HAND TO A DEPTH OF 1-2 INCHES. D. SECURING STRAW MULCH: STRAW MULCH SHALL BE SECURED IMMEDIATELY FOLLOWING MULCH APPLICATIONS TO MIMIMIZE MOVEMENT OF WIND OR WATER. THE FOLLOWING METHODS ARE PERMITTED: . USE A MULCH ANCHORING TOOL WHICH IS DESIGNED TO PUNCH AND ANCHOR FABRIC TYPE MULCH INTO THE SOIL SURFACE TO A MINIMUM DEPTH OF 2 INCHES. THIS IS THE MOST EFFECTIVE METHOD FOR SECURING MULCH, HOWEVER, IT IS LIMITED TO RELATIVELY FLAT AREAS WHERE EQUIPMENT CAN OPERATE SAFELY.

ii. WOOD CELLULOSE FIBER MAY BE USED FOR ANCHORING STRAW. APPLY THE FIBER BINDER AT A NET DRY WEIGHT OF 750 POUNDS PER ACRE. IF MIXED WITH WATER, USE 50 POUNDS OF WOOD CELLULOSE FIBER PER 100 GALLONS OF WATER. iii. LIQUID BINDERS MAY BE USED AND APPLIED HEAVIER AT THE EDGES WHERE WIND CATCHES MULCH, SUCH AS IN VALLEYS AND ON CRESTS OF SLOPES. THE REMAINDER OF THE AREA SHOULD APPEAR

UNIFORM AFTER BINDER APPLICATION iv. LIGHTWEIGHT NETTING, MAY BE USED TO SECURE MULCH. THE NETTING WILL BE STAPLED TO THE GROUND ACCORDING TO MANUFACTURERS' RECOMMENDATIONS.

#### 2. TEMPORARY SEEDING:

LIME: 100 POUNDS OF DOLOMITIC LIMESTONE PER 1,000 SF FERTILIZER: 15 POUNDS OF 10-10-10 PER 1,000 SF SEED: PERENNIAL RYE-0.92 POUNDS PER 1,000 SF

NO FILLS MAY BE PLACED ON FROZEN GROUND. ALL FILL TO BE PLACED IN APPROXIMATELY HORIZONTAL LAYERS, EACH LAYER HAVING A LOOSE THICKNESS OF NOT MORE THAN 8 INCHES. ALL FILL IN ROADWAYS AND PARKING AREAS IS TO BE CLASSIFIED TYPE 2 COMPACTED TO 90% DENSITY: COMPACTION TO BE DETERMINED BY ASTM D-1557-66T (MODIFIED PROCTOR). ANY FILL WITHIN THE BUILDING AREA IS TO BE COMPACTED TO A MINIMUM OF OF 95% AS DETERMINED BY METHODS PREVIOUSLY MENTIONED. FILLS FOR POND EMBANKMENTS SHALL BE COMPACTED AS PER THE PROJECT ENGINEER'S SPECIFICATIONS. ALL OTHER FILLS SHALL BE COMPACTED SUFFICIENTLY SO AS TO BE STABLE AND PREVENT EROSION AND SLIPPAGE.

INSTALLATION OF SOD SHOULD FOLLOW THE PERMANENT SEEDING DATES. PERMANENT SOD IS TO BE STATE APPROVED SOD; LIME AND FERTILIZER PER PERMANENT SEEDING SPECIFICATIONS AND LIGHTLY

IRRIGATE SOIL PRIOR TO LAYING SOD. SOD IS TO BE LAID ON THE CONTOUR WITH ALL ENDS TIGHTLY ABUTTING. JOINTS ARE TO BE STAGGERED BETWEEN ROWS. WATER AND ROLL OR TAMP SOD TO INSURE POSITIVE

#### ROOT CONTACT WITH THE SOIL. ALL SLOPES STEEPER THAN 3:1, AS SHOWN, ARE TO BE PERMANENTLY SODDED OR PROTECTED WITH APPROVED EROSION CONTROL NETTING. ADDITIONAL WATERING FOR STABLISHMENT MAY BE REQUIRED. SOD IS NOT TO BE APPLIED ON FROZEN GROUND. SOD SHALL NOT BE HARVESTED OR TRANSPLANTED WHEN MOISTURE CONTENT (DRY OR WET) AND/OR EXTREME TEMPERATURI MAY ADVERSELY AFFECT ITS SURVIVAL. IN THE ABSENCE OF ADEQUATE RAINFALL, IRRIGATION SHOULD BE PERFORMED TO INSURE ESTABLISHED SOD.

#### SLOPE STABLIZATION. SEEDING METHOD & MULCHING SLOPES OR 4:1 OR GREATER (HORIZONTAL: VERTICAL)

SLOPES SHALL BE HYDROSEEDED WITH THE MIXTURES AND RATES INDICATED IN THE PERMANENT SEEDING MIXTURE SCHEDULE. STRAW OR HAY MULCH SHALL BE APPLIED AT A RATE OF 2,000 LBS./ACRE. STRAW OR HAY MULCH SHALL BE ANCHORED WITH BIOD-Mesh60 NETTING AS MANUFACTURED BY ROLANKA INTERNATIONAL OR APPROVED EQUIVALENT. NETTING TO BE INSTALLED PER MANUFACTURER SPECIFICATIONS.

#### GENTLE SLOPE AND FLAT AREAS

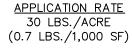
AREA SHALL BE SEEDED BY HYDROSEEDING OR BRODCASTING WITH THE MIXTURES AND RATES INDICATED ON THE PERMANENT SEEDING MIXTURE SCHEDULE. HYDROSEEDED AREAS SHALL BE MULCHED WITH A WOOD FIBER MULCH APPLIED AT A RATE OF 500 LBS./ACRE. BROADCAST AREAS SHAL BE MULCHED WITH HAY OR STRAW AT A RATE OF 2,000 LBS./ACRE. AREAS SEEDED BY BROADCASTING SHALL BE LIGHTLY RAKED AND PACED PRIOR TO PLACING

AREAS REMAINING DISTURBED FOR 20 DAYS OR MORE SHALL BE STABLIZED AS FOLLOWS:

SCARIFY SOILS IF COMPACTED, LIME TO pH OF 6.0 IF REQUIRED, FERTILIZE WITH 600 LBS./ACRE. 5-10-10 FERTILIZER IF REQUIRED. SEED WITH SPECIES AND RATE SHOWN BELOW. MULCH WITH HAY OR STRAW AT A RATE OF 2,000 LBS./ACRE. ANCHOR MULCH WITH NETTING OF WOOD FIBER OR JUTE IF STEEP SLOPE OR HIGH POTENTIAL FOR EROSION.

RYEGRASS (ANNUAL OR PERENNIAL)

(USE WINTER RYE IF SEEDING IN OCT./NOV.)



#### -STAKE (TYP.) å DIA. STEEL WIRE STAPLE DETAIL STAPLES (2 PER BALE) STRAW BALE **IMPERMEABLE** SHEETING . . WOOD OR METAL STAKES -(2 PER BALE) **IMPERMEABLE** STRAW SHEETING BALE (TYP.) <u>PLAN</u> SECTION B-B

| PAVEMENT -

10'MIN.

10'MIN.

∠ MOUNTABLE BERM

(OPTIONAL)

**PROFILE** 

<u>PLAN VIEW</u>

1. STONE SIZE - USE 2" STONE, OR RECLAIMED OR RECYCLED CONCRETE EQUIVALENT.

2. LENGTH - NOT LESS THAN 50 FEET (EXCEPT ON A SINGLE RESIDENCE LOT WHERE

4. WIDTH - TWELVE (12) FOOT MINIMUM, BUT NOT LESS THAN THE FULL WIDTH AT

5. FILTER CLOTH - WILL BE PLACED OVER THE ENTIRE AREA PRIOR TO PLACING

6. SURFACE WATER - ALL SURFACE WATER FLOWING OR DIVERTED TOWARD CON-STRUCTION ENTRANCES SHALL BE PIPED ACROSS THE ENTRANCE. IF PIPING IS

8. WHEN WASHING IS REQUIRED, IT SHALL BE DONE ON A AREA STABILIZED WITH

9. PERIODIC INSPECTION AND NEEDED MAINTENANCE SHALL BE PROVIDED AFTER EACH

NOT TO SCALE

STONE AND WHICH DRAINS INTO AN APPROVED SEDIMENT TRAPPING DEVICE.

STABILIZED CONSTRUCTION ENTRANCE

FOR CONSTRUCTION SPECIFICATIONS REFER TO "NY GUIDELINES

FOR URBAN EROSION AND SEDIMENT CONTROL"

7. MAINTENANCE - THE ENTRANCE SHALL BE MAINTAINED IN A CONDITION WHICH WILL

PREVENT TRACKING OR FLOWING OF SEDIMENT ONTO PUBLIC RIGHTS-OF-WAY, ALL

SEDIMENT SPILLED, DROPPED, WASHED OR TRACTED ONTO PUBLIC RIGHTS-OF-WAY

IMPRACTICAL, A MOUNTABLE BERM WITH 5:1 SLOPES WILL BE PERMITTED.

POINTS WHERE INGRESS OR EGRESS OCCURS. TWENTY-FOUR (24) FOOT IF SINGLE

FILTER —

**CONSTRUCTION SPECIFICATIONS** 

MUST BE REMOVED IMMEDIATELY

ENTRANCE TO SITE.

A 30 FOOT MINIMUM LENGTH WOULD APPLY).

3. THICKNESS - NOT LESS THAN SIX (6) INCHES.

GROUND

**EXISTING** 

GROUND

#### CONCRETE WASHOUT AREA WITH STRAW BALES NOT TO SCALE

#### NOTE:

CAN BE TWO STACKED BALES OR PARTIALLY EXCAVATED TO REACH 3 FT DEPTH

#### CONSTRUCTION SPECIFICATIONS

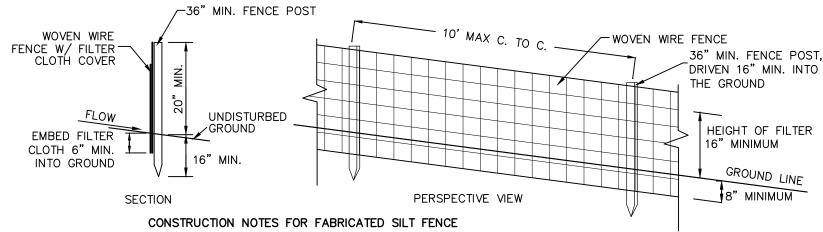
1. LOCATE WASHOUT STRUCTURE A MINIMUM OF 50 FEET AWAY FROM OPEN CHANNELS, STORM DRAIN INLETS, SENSITIVE AREAS, WETLANDS. BUFFERS AND WATER COURSES AND AWAY FROM CONSTRUCTION TRAFFIC.

2. SIZE WASHOUT STRUCTURE FOR VOLUME NECESSARY TO CONTAIN WASH WATER AND SCUDS AND MAINTAIN AT LEAST 4 INCHES OF FREEBOARD. TYPICAL DIMENSIONS ARE 10 FEET X 10 FEET X 3 FEET DEEP.

3. PREPARE SOIL BASE FREE OF ROCKS OR OTHER DEBRIS THAT MAY CAUSE TEARS OR HOLES IN THE LINER. FOR LINER. USE 10 MIL OR THICKER UV RESISTANT. IMPERMEABLE SHEETING, FREE OF HOLES AND TEARS OR OTHER DEFECTS THAT COMPROMISE IMPERMEABILITY OF

#### 4. PROVIDE A SIGN FOR THE WASHOUT IN CLOSE PROXIMITY TO THE FACILITY.

5. KEEP CONCRETE WASHOUT STRUCTURE WATER TIGHT. REPLACE IMPERMEABLE LINER IF DAMAGED (EG., RIPPED OR PUNCTURED). EMPTY OR REPLACE WASHOUT STRUCTURE THAT IS 75 PERCENT FULL, AND DISPOSE OF ACCUMULATED MATERIAL PROPERLY. DO NOT REUSE PLASTIC LINER. WET-VACUUM STORED LIQUIDS THAT HAVE NOT EVAPORATED AND DISPOSE OF IN AN APPROVED MANNER. PRIOR TO FORECASTED RAINSTORMS, REMOVE LIQUIDS OR COVER STRUCTURE TO PREVENT OVERFLOWS. REMOVE HARDENED SOLIDS. WHOLE OR BROKEN UP. FOR DISPOSAL OR RECYCLING. MAINTAIN RUNOFF DIVERSION AROUND EXCAVATED WASHOUT STRUCTURE UNTIL STRUCTURE IS



- WOVEN WIRE FENCE TO BE FASTENED SECURELY TO FENCE POST WITH WIRE TIES OR STAPLES.
- 2. FILTER CLOTH TO BE FASTENED SECURELY TO WOVEN WIRE FENCE WITH TIES SPACED EVERY 24" AT TOP AND MID SECTION.
- 3. WHEN TWO SECTIONS OF FILTER CLOTH ADJOIN EACH OTHER THEY
- SHALL BE OVERLAPPED BY 6" AND FOLDED. MAINTENANCE SHALL BE PERFORMED AS NEEDED AND MATERIAL
- REMOVED WHEN 'BULGES' DEVELOP IN THE SILT FENCE.

POST: STEEL EITHER 'T' OR 'U' TYPE OR 2" HARDWOOD

FENCE: WOVEN WIRE, 14 1/2 GA. 6" MAX. MESH OPENING FILTER CLOTH: FILER X, MÍRAFI 100X, STABILINKA T140N OR APPROVED EQUAL PREFABRICATED UNIT: GEIOFAB, ENVIROFENCE, OR APPROVED EQUAL.

## SILT FENCE DETAIL

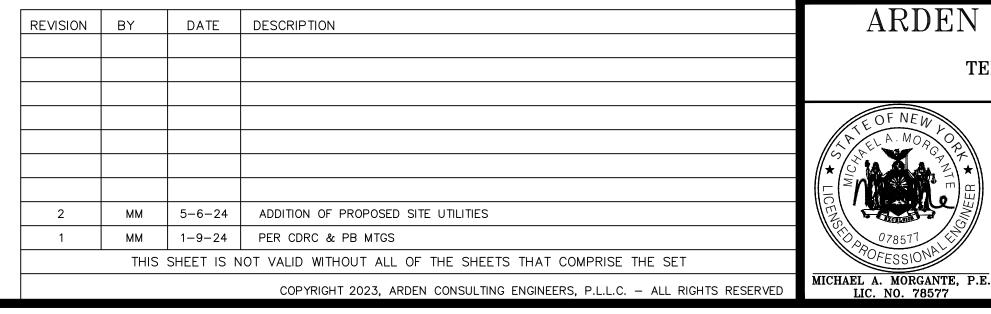
#### SEDIMENT AND EROSION CONTROL NOTES AND CONSTRUCTION **SEQUENCING**

- PRE-CONSTRUCTION MEETING: BEFORE CONSTRUCTION ACTIVITIES A SITE EVALUATION OF THE SITE WILL BE PERFORMED WITH SITE CONTRACTOR AND VILLAGE PERSONNEL, INCLUDING MARK-OUT AREAS OF SPECIAL CONCERNS (I.E. TREES, WETLANDS, WELLS, ETC.).
- LIMITS OF SITE CLEARING: BEFORE ANY ACTUAL CONSTRUCTION, FLAGS ARE TO BE PLACED IN THE FIELD DELINEATING LIMITS OF DISTURBANCE INCLUDING SPECIAL AREAS OF CONCERN AS HIGHLIGHTED DURING THE PRE-CONSTRUCTION
- CONSTRUCT STABILIZED CONSTRUCTION ENTRANCE WHERE SHOWN ON THE PLAN.
- INSTALL SEDIMENT BARRIERS/SWALES/DITCHES/DIKES AT DOWN-SLOPE AREAS FROM ALL PROPOSE GRADING OPERATIONS, AND INSTALL OTHER SEDIMENTATION AND EROSION CONTROL STRUCTURES OR MEASURES AS SHOWN ON THE DRAWINGS.
- LAND DISTURBANCE SHALL BE LIMITED TO ONLY THAT AREA NECESSARY FOR DEVELOPMENT. NO MORE THAN 5 ACRES OF UNPROTECTED SOIL SHALL BE DISTURBED AT ONE TIME. PREVIOUS EARTHWORK SHALL BE STABILIZED AS SPECIFIED BEFORE ADDITIONAL AREA IS EXPOSED.
- PROTECT ALL TREES WHICH ARE TO REMAIN AND WHICH ARE IN OR NEAR CONSTRUCTION AREAS AS DIRECTED IN THE FIELD WITH SNOW FENCING PLACED AROUND THE TREE TRUNK, PLEASE SNOW FENCING AT THE DRIP LINE SURROUNDING TREES, IF POSSIBLE, OR TO MAINTAIN A MINIMUM DIAMETER OF 10 FEET AROUND TREES. WE ARE FENCING MUST BE PLEASED CLOSER THAN THE DRIP LINE, PLACE 4 INCHES OF WOOD CHIPS OVER ROOT ZONE TO EXTEND TO THE DRIP LINE. MAINTAIN THIS WOOD CHIP PROTECTION FOR THE DURATION OF CONSTRUCTION.
- CLEAR EXISTING TREES AND VEGETATION FROM AREAS TO BE EXCAVATED OR FILLED, THEN STRIP AND STOCKPILE TOPSOIL FROM ALL AREAS TO BE DISTURBED. SEED STOCKPILED TOPSOIL WITH TEMPORARY RYEGRASS COVER AND SPECIFIED BELOW (SEE NOTE 8), AND ERECT A SILT FENCE AROUND THE STOCKPILE.
- PERFORM NECESSARY EXCAVATION OR FILL OPERATIONS TO BRING SITE TO DESIRED SUBGRADE. PROTECT AREA OF PROPOSED STORM DRAINAGE SYSTEM DURING CONSTRUCTION. PROTECT THE INFILTRATION AREA FROM COMPACTION DURING CONSTRUCTION AND FROM SILT LADEN RUNOFF. AN ORANGE CONSTRUCTION FENCE SHALL BE PLACED AROUND THE INFILTRATION SYSTEM DURING SITE CONSTRUCTION TO PREVENT RUTTING AND COMPACTION.
- INSTALL SENTIMENT BARRIERS AROUND ALL STORM DRAIN INLETS. OR MODIFY SEDIMENT CONTROL MEASURES INSTALLED AND #2 ABOVE AND MAINTAIN UNTIL ALL DISTURBED AREAS ARE STABILIZED WITH VEGETATION AND ALL PAVEMENTS ARE PAVED WITH A BASE COURSE.
- 10. SEED ALL DISTURBED AREAS WHICH REMAIN UNDISTURBED FOR 14 DAYS OR MORE AND WHICH WILL NOT BE UNDER CONSTRUCTION WITHIN 14 DAYS WITH TEMPORARY VEGETATIVE MEASURES DESCRIBED ON THIS SHEET.
- 11. IF CONSTRUCTION IS SUSPENDED OR COMPLETED, ALL DISTURBED AREAS SHALL BE SEEDED AND MULCHED IMMEDIATELY. ALL SLOPES STEEPER THAN ONE ON THREE (V/H) AND PERIMETER TRENCHES AND TRAP EMBANKMENTS SHALL, ON COMPLETION, BE IMMEDIATELY STABILIZE WITH TEMPORARY SEATING AND MULCHING.
- 12. AFTER COMPLETION OF SITE CONSTRUCTION, FINE GRADE AND SPREAD TOPSOIL ON ALL LAWN AREAS AND SEED WITH PERMANENT LAWN MIX AS DESCRIBED ON THIS SHEET.
- 13. DURING THE PROGRESS OF CONSTRUCTION, MAINTAIN ALL SEDIMENT TRAPS, BARRIERS, AND FILTERS AS NECESSARY TO PREVENT CLOGGING WITH SEDIMENT.
- 14. AFTER PAVEMENTS ARE INSTALLED AND PERMANENT VEGETATIVE COVER AND PLANTINGS ARE ESTABLISHED, REMOVE SEDIMENT BARRIERS AND SEED THOSE DISTURBED AREAS.
- 15. MAINTAIN ALL SEEDED AND PLANTED AREAS TO ENSURE A VIABLE STABILIZED VEGETATIVE COVER.
- 16. STRUCTURAL MEASURES MUST BE MAINTAINED TO BE EFFECTIVE. IN GENERAL, THESE MEASURES MUST BE PERIODICALLY INSPECTED TO ENSURE STRUCTURAL INTEGRITY, TO DETECT VANDALISM DAMAGE, AND FOR CLEANING AND REPAIR WHENEVER NECESSARY.
- 17. DURING CONSTRUCTION, ALL STRUCTURES SHOULD BE INSPECTED WEEKLY AND AFTER EVERY 1/2 INCH RAINFALL EVENT. REMOVE ACCUMULATED SEDIMENT AND STOCKPILE AND STABILIZE IN AREA NOT SUBJECT TO FURTHER EROSION. SWPPP INSPECTIONS AND REPORTS WILL BE PREPARED BY A QUALIFIED PERSON AFTER EACH INSPECTION. THE REPORT IS TO BE FILED WITH THE RESPONSIBLE PRATY ON-SITE, BUILDING INSPECTOR AND THE VILLAGE ENGINEER WITHIN 24-HOURS OF THE INSPECTION.
- 18. AFTER CONSTRUCTION IS COMPLETED, PERMANENT SETTLEMENT OR EROSION CONTROL STRUCTURES SHOULD BE INSPECTED AT LEAST SEMI ANNUALLY AND AFTER EVERY RAIN.

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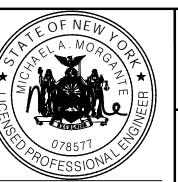
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SITE PLAN FOR 520 - 530 ROUTE 208 VILLAGE OF SOUTH BLOOMING GROVE ORANGE COUNTY, N.Y.

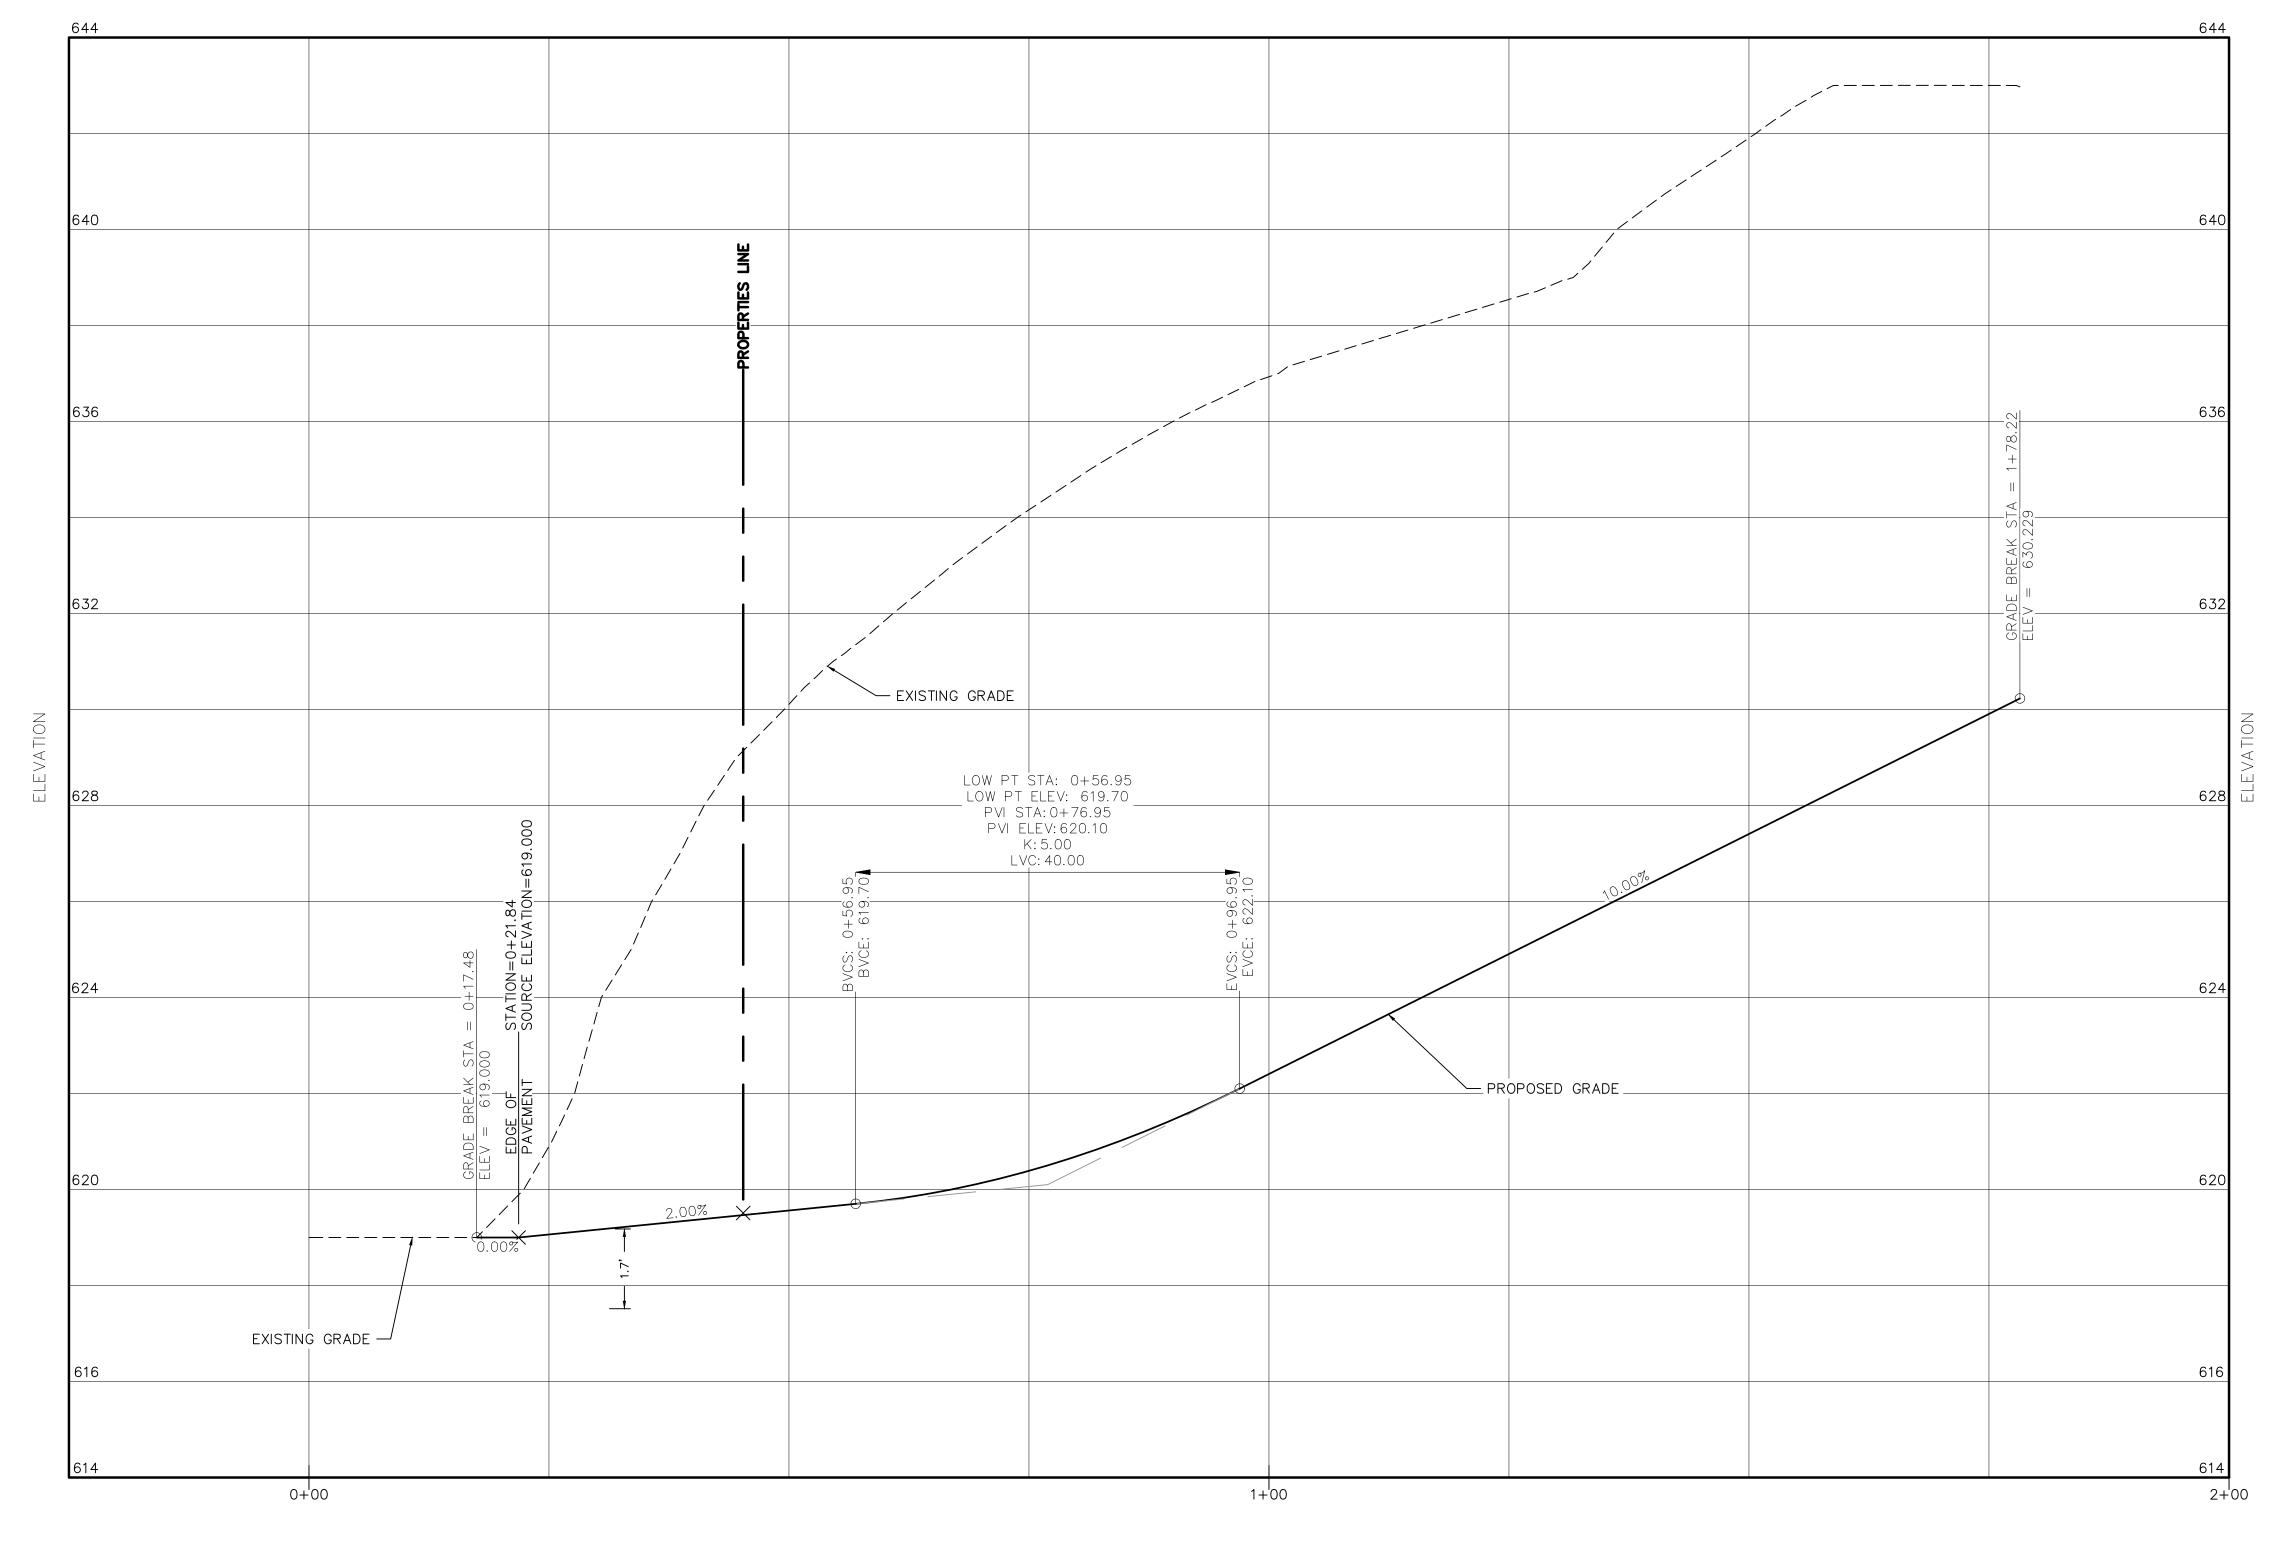
EROSION & SEDIMENT CONTROL DETAILS

MM CHECKED: MM SHEET NO.

23-010

AS NOTED

SCALE:



DRIVEWAY PROFILE

HORIZONTAL: 1"=10'

VERTICAL: 1"=2'

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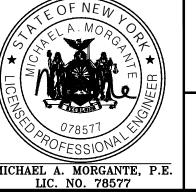
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	DESCRIPTION	DATE	BY	REVISION
<b>1</b> //,				
1 ( =				
	ADDITION OF PROPOSED SITE UTILITIES	5-6-24	ММ	2
	PER CDRC & PB MTGS	1-9-24	ММ	1
	THIS SHEET IS NOT VALID WITHOUT ALL OF THE SHEETS THAT COMPRISE THE SET			
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520 - 530 ROUTE 208 VILLAGE OF SOUTH BLOOMING GROVE ORANGE COUNTY, N.Y.

JOB#:
23-010
SCALE:
AS NOTED
DATE:

12-14-23 DRAWN:

MM CHECKED: MM SHEET NO. 08 of 10

DRIVEWAY PROFILE

